

Report to Planning Committee

29 November 2023

Application Reference	DC/23/68420
Application Received	27 June 2023
Application Description	Proposed 11 No. houses and 9 No. self-
	contained apartments with car parking,
	enclosed bin store, cycle store and
	landscaping.
Application Address	Site Of Former 3 And 4
	Cardale Street
	Rowley Regis
Applicant	Sandwell MBC
Ward	Blackheath
Contact Officer	Carl Mercer
	carl_mercer@sandwell.gov.uk

1 Recommendations

- 1.1 That, subject to the signing of a section 106 agreement to ensure affordable housing, planning permission is granted subject conditions relating to:
 - (i) External materials;
 - (ii) Finished floor levels;
 - (iii) Employment and skills plan;
 - (iv) Contamination;
 - (v) Drainage (surface and foul);



















- (vi) Energy statement (compliance with submitted info);
- (vii) Boundary treatments (compliance with submitted info);
- (viii) Landscaping (compliance with submitted info);
- (ix) Waste storage (compliance with submitted info);
- (x) Cycle storage (compliance with submitted info);
- (xi) Low NOx boilers;
- (xii) Electric vehicle charging;
- (xiii) Construction environmental management plan;
- (xiv) Removal of permitted development rights; and
- (xv) Retention of parking and manoeuvring areas.

2 Reasons for Recommendations

2.1 The proposal raises no significant concerns from a policy, design or highway perspective and would deliver affordable housing in a sustainable location.

2 How does this deliver objectives of the Corporate Plan?

	Strong resilient communities
	Quality homes in thriving neighbourhoods
(23)	A strong and inclusive economy

4 Context

4.1 The application is being reported to your Planning Committee as a section 106 agreement is required to secure the affordable housing.



















4.2 To assist members with site context, a link to Google Maps is provided below:

Cardale Street, Rowley Regis

5 Key Considerations

- 5.1 Material planning considerations (MPCs) are matters that can and should be taken into account when making planning decisions. By law, planning decisions should be made in accordance with the development plan unless MPCs indicate otherwise. This means that if enough MPCs weigh in favour of a development, it should be approved even if it conflicts with a local planning policy.
- 5.2 The material planning considerations which are relevant to this application are:

Government policy (NPPF); Layout and density of buildings; Design, appearance and materials; Access, highway safety, parking and servicing; and Presumption and the 'titled balance'.

6. The Application Site

- 6.1 The application site is bounded to the northwest by a relatively recent housing development and a Hindu temple. Cardale Street runs to the north east, from which much of the development would be accessed from. The remainder of the proposed housing would be accessed from Park Street, adjacent to an existing carpet warehouse. To the south of the site lies a run of housing which fronts on to Avenue Road.
- 6.2 The site is unallocated in the Development Plan.

7. Planning History

7.1 None relevant.



















8. Application Details

- 8.1 The applicant proposes 11 houses and nine self-contained apartments for affordable rental. The site would have two access points. A 2.5 storey block of apartments would front Cardale Street, with parking accessed off Cardale Street by a driveway to the rear. The same driveway would serve five, two storey houses. Six houses would be accessed from Park Street, with two sited along the Park Street frontage and four served by a driveway to a cul-de-sac at the rear.
- 8.2 Of the 20 dwellings proposed, there would be one block of nine, one-bedroom apartments; six, two-bedroom and five, three-bedroom houses. Each two-bedroom house would have one off-street parking space, each three-bedroom house would have two spaces, whilst the apartments would each have one allocated space. The houses served off Park Street would also have the use of two off-street visitor spaces. Secure cycle storage for nine bikes is provided adjacent to the apartment block amenity area.
- 8.3 Amended plans have been received to address design and highway issues. The amendments were required to bring the layout in line with the Council's design guidance, raise the internal space proposed, clarify boundary treatments, improve access arrangements and increase parking space sizes.

9. Publicity

9.1 The application has been publicised by neighbour notification letter and site notice, with two representations being received.

9.2 Representations

Representations have been received on grounds of drainage and boundary treatments.

These will be addressed in section 13 (Material Considerations).



















10. Consultee responses

10.1 Planning Policy

No objection. The proposals raise no significant policy concerns although the applicant should look to demonstrate how policy ENV7 (renewable energy requirement) would be met. A statement has now been submitted which provides details of photovoltaics as part of the development and is conditioned as such.

10.2 Highways

No objection.

10.3 Urban Design

No objection.

10.4 Pollution Control (Contamination)

No objection subject to conditions relating to the final design and specification of gas protection measures and submission of a validation report.

10.4 Pollution Control (Air)

No objection. Electric vehicle charging (EVC) bays, low NOx boilers and construction environmental management plan required by condition.

10.5 West Midlands Police

No objection.





















10.6 Staffordshire County Council – Lead Local Flood Authority (LLFA)

Further information required. In my opinion the issues raised are not insurmountable and can be addressed by condition. However, the applicant has submitted further detail which the LLFA is currently considering. The application can still be determined without further comments from Staffordshire as conditions can be applied.

10.7 Severn Trent Water

No objection subject to condition. Seven Trent note the presence of their sewer pipe across the site. The easement is noted on the submitted plan and the scheme has been designed around it.

11. National Planning Policy

- 11.1 National Planning Policy Framework promotes sustainable development but states that local circumstances should be taken into account to reflect the character, needs and opportunities for each area. The NPPF refers to development adding to the overall quality of the area by achieving high quality design, achieving good architecture and layouts.
- 11.2 Taking into account the views of the Council's Urban Design officer, I am of the opinion that the scheme is of a good design, in accordance with the design aspirations of the NPPF, as the development would assimilate with the overall form and layout of the site's surroundings.

12. Local Planning Policy

12.1 The following polices of the Council's Development Plan are relevant:

Black Country Core Strategy (BCCS)

CSP4 - Place Making

DEL1 - Infrastructure Provision

HOU2 - Housing Density, Type and Accessibility





















HOU3 – Delivering Affordable Housing

TRAN2 - Managing Transport Impacts of New Development

TRAN4 – Creating Coherent Networks for Cycling and Walking

ENV3 – Design Quality

ENV5 - Flood Risk, SuDS and Urban Heat Island Effect

ENV7 – Renewable Energy

ENV8 – Air Quality

Site Allocations and Delivery Development Plan Document (SADD)

SAD H2 – Housing Windfalls

SAD H3 – Affordable Housing

SAD EOS9 – Urban Design Principles

- 12.2 In respect of CSP4 the design of the development is influenced by the context of the local area and would enhance the attributes the area offers in terms of its local character.
- 12.3 Infrastructure provision, in this case EVC bays, would be ensured by condition (DEL1).
- 12.4 Whilst land is identified and allocated in the Development Plan to meet the borough's sustainable housing growth, under policy HOU1 additional housing capacity will also be sought elsewhere through planning permissions on suitable sites. As such, this proposal would assist with providing much needed housing within the borough.
- 12.5 The proposal meets the requirements of policy HOU2 in that it proposes a range of types and sizes of accommodation which would be accessible by walking and sustainable transport to services. The proposal would also achieve good design with minimal amenity impact.
- 12.6 The scheme is entirely comprised of affordable housing which would be ensured by s106 agreement (HOU3 and SAD H3).



















- 12.7 Training and recruitment opportunities should be provided as part of any new development (EMP5 and SAD EMP 2). This can be ensured by condition.
- 12.8 Highways raise no objection to the traffic generation attributed to this development (TRAN2).
- 12.9 Sufficient amenity space is provided to allow for cycle parking provision (TRAN4).
- 12.10 The proposal raises no significant concerns in respect of design and is therefore compliant with policy ENV3 and SAD EOS 9.
- 12.11 Drainage can be addressed by the submission of further information and/or a compliance condition (ENV5).
- 12.12 The development would use photovoltaics and is estimated that the energy generated would be 11.71% of the energy demand of the site. This exceeds the 10% requirement of the policy ENV7.
- 12.13 In respect of air quality (ENV8), electric vehicle charging points and low NOx boilers can be ensured by condition.
- 12.14 The proposed dwellings would be a windfall, subject to SAD H2. The proposal meets the requirement of the policy as it is previously developed land, suitable for residential development, and capable of meeting other plan policies.

13. Material Considerations

13.2 Layout and density of buildings / Design, appearance and materials

The Urban Design officer has confirmed that the layout of the proposal is broadly in line with the Council's residential design guidance. The scale of the development would be two storeys, and the proposal would assimilate into the surrounding area.



















13.3 Access, highway safety, parking and servicing

The development meets with the approval of the highway authority and parking spaces are in accordance with the requirements of Council design guidance.

13.4 Presumption and the 'titled balance'

The 'tilted balance' is similar to the normal planning balance but it is only engaged in exceptional circumstances. As the council has less than a five-year housing land supply, relevant local policies are out-of-date. In the most basic sense, the tilted balance is a version of the planning balance that is already tilted in an applicant's favour. If the tilted balance applies, planning permission should normally be granted unless the negative impacts 'significantly and demonstrably' outweigh the positive impacts.

13.5 Other matters

Representations refer to past/existing issues with drainage and the rear boundary along Avenue Road. Foul drainage matters would be dealt with by Severn Trent. In respect of the development, the applicant has noted the presence of the sewer easement within the site and the development would not disturb this asset. Furthermore, the brick boundary wall to the rear of properties along Avenue Road would be retained.

14. Conclusion and planning balance

14.1 All decisions on planning applications should be based on an objective balancing exercise. This is known as applying the "planning balance". It is established by law that planning applications should be refused if they conflict with the development plan unless material considerations indicate otherwise. This essentially means that the positive impacts of a development should be balanced against its negative impacts.



















14.2 On balance the proposal accords with the provisions of relevant Development Plan policies and there are no significant material considerations which warrant refusal of the application.

15 Alternative Options

15.1 Refusal of the application is an option if there are material planning reasons for doing so. In my opinion the proposal is compliant with relevant polices and there are no material considerations that would justify refusal.

16 Implications

Resources: Legal and Governance:	When a planning application is refused the applicant has a right of appeal to the Planning Inspectorate, and they can make a claim for costs against the Council. This application is submitted under the Town and Country Planning Act 1990.
Risk:	None.
Equality:	There are no equality issues arising from this proposal and therefore an equality impact assessment has not been carried out.
Health and Wellbeing:	None.
Social Value	None.
Climate Change	Sandwell Council supports the transition to a low carbon future, in a way that takes full account of the need to adapt to and mitigate climate change. Proposals that help to shape places in ways that contribute to radical reductions in greenhouse gas emissions, minimise vulnerability and improve resilience; encourage the reuse of existing resources, including the conversion of existing buildings; and support renewable and low carbon energy and associated infrastructure, will be welcomed.





















17. Appendices

Location Plan

Context Plan

M4961(PL)01 L

M4961(PL)02 B

M4961(PL)05 F

M4961(PL)06 D

M4961(PL)07 A

M4961(PL)08 B

M4961(PL)09 A

M4961(PL)10 A

M4961(PL)11 A

M4961(PL)12 B

M4961(PL)13 A

M4961(PL)14 A

M4961 (PL) 15




















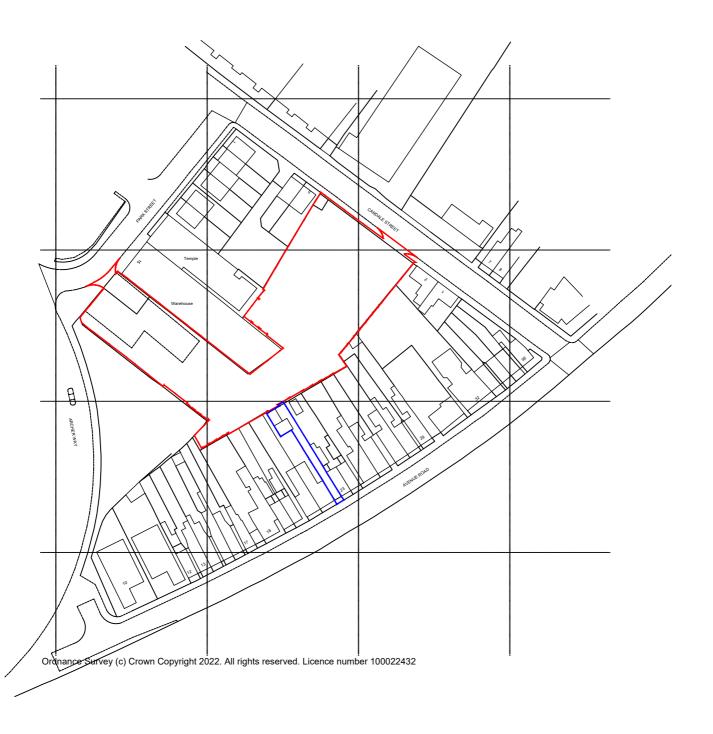




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Drawing Number: (Job number)	M4961	(PL)	100	Revision:
Scale:	1:1250 @ A	1		
Date:	Nov 22			
Drawn by/ checked b	y: RW			







Date Details Fencing details added. June 23 July 23 Boundary treatments amended to suit Enrok's comments. Amendments to cycle and refuse stores, parking widths, addition of timber knee Sept 23 rails and EV chargers. Flats amended to 50sqm. All to Planner's comments.

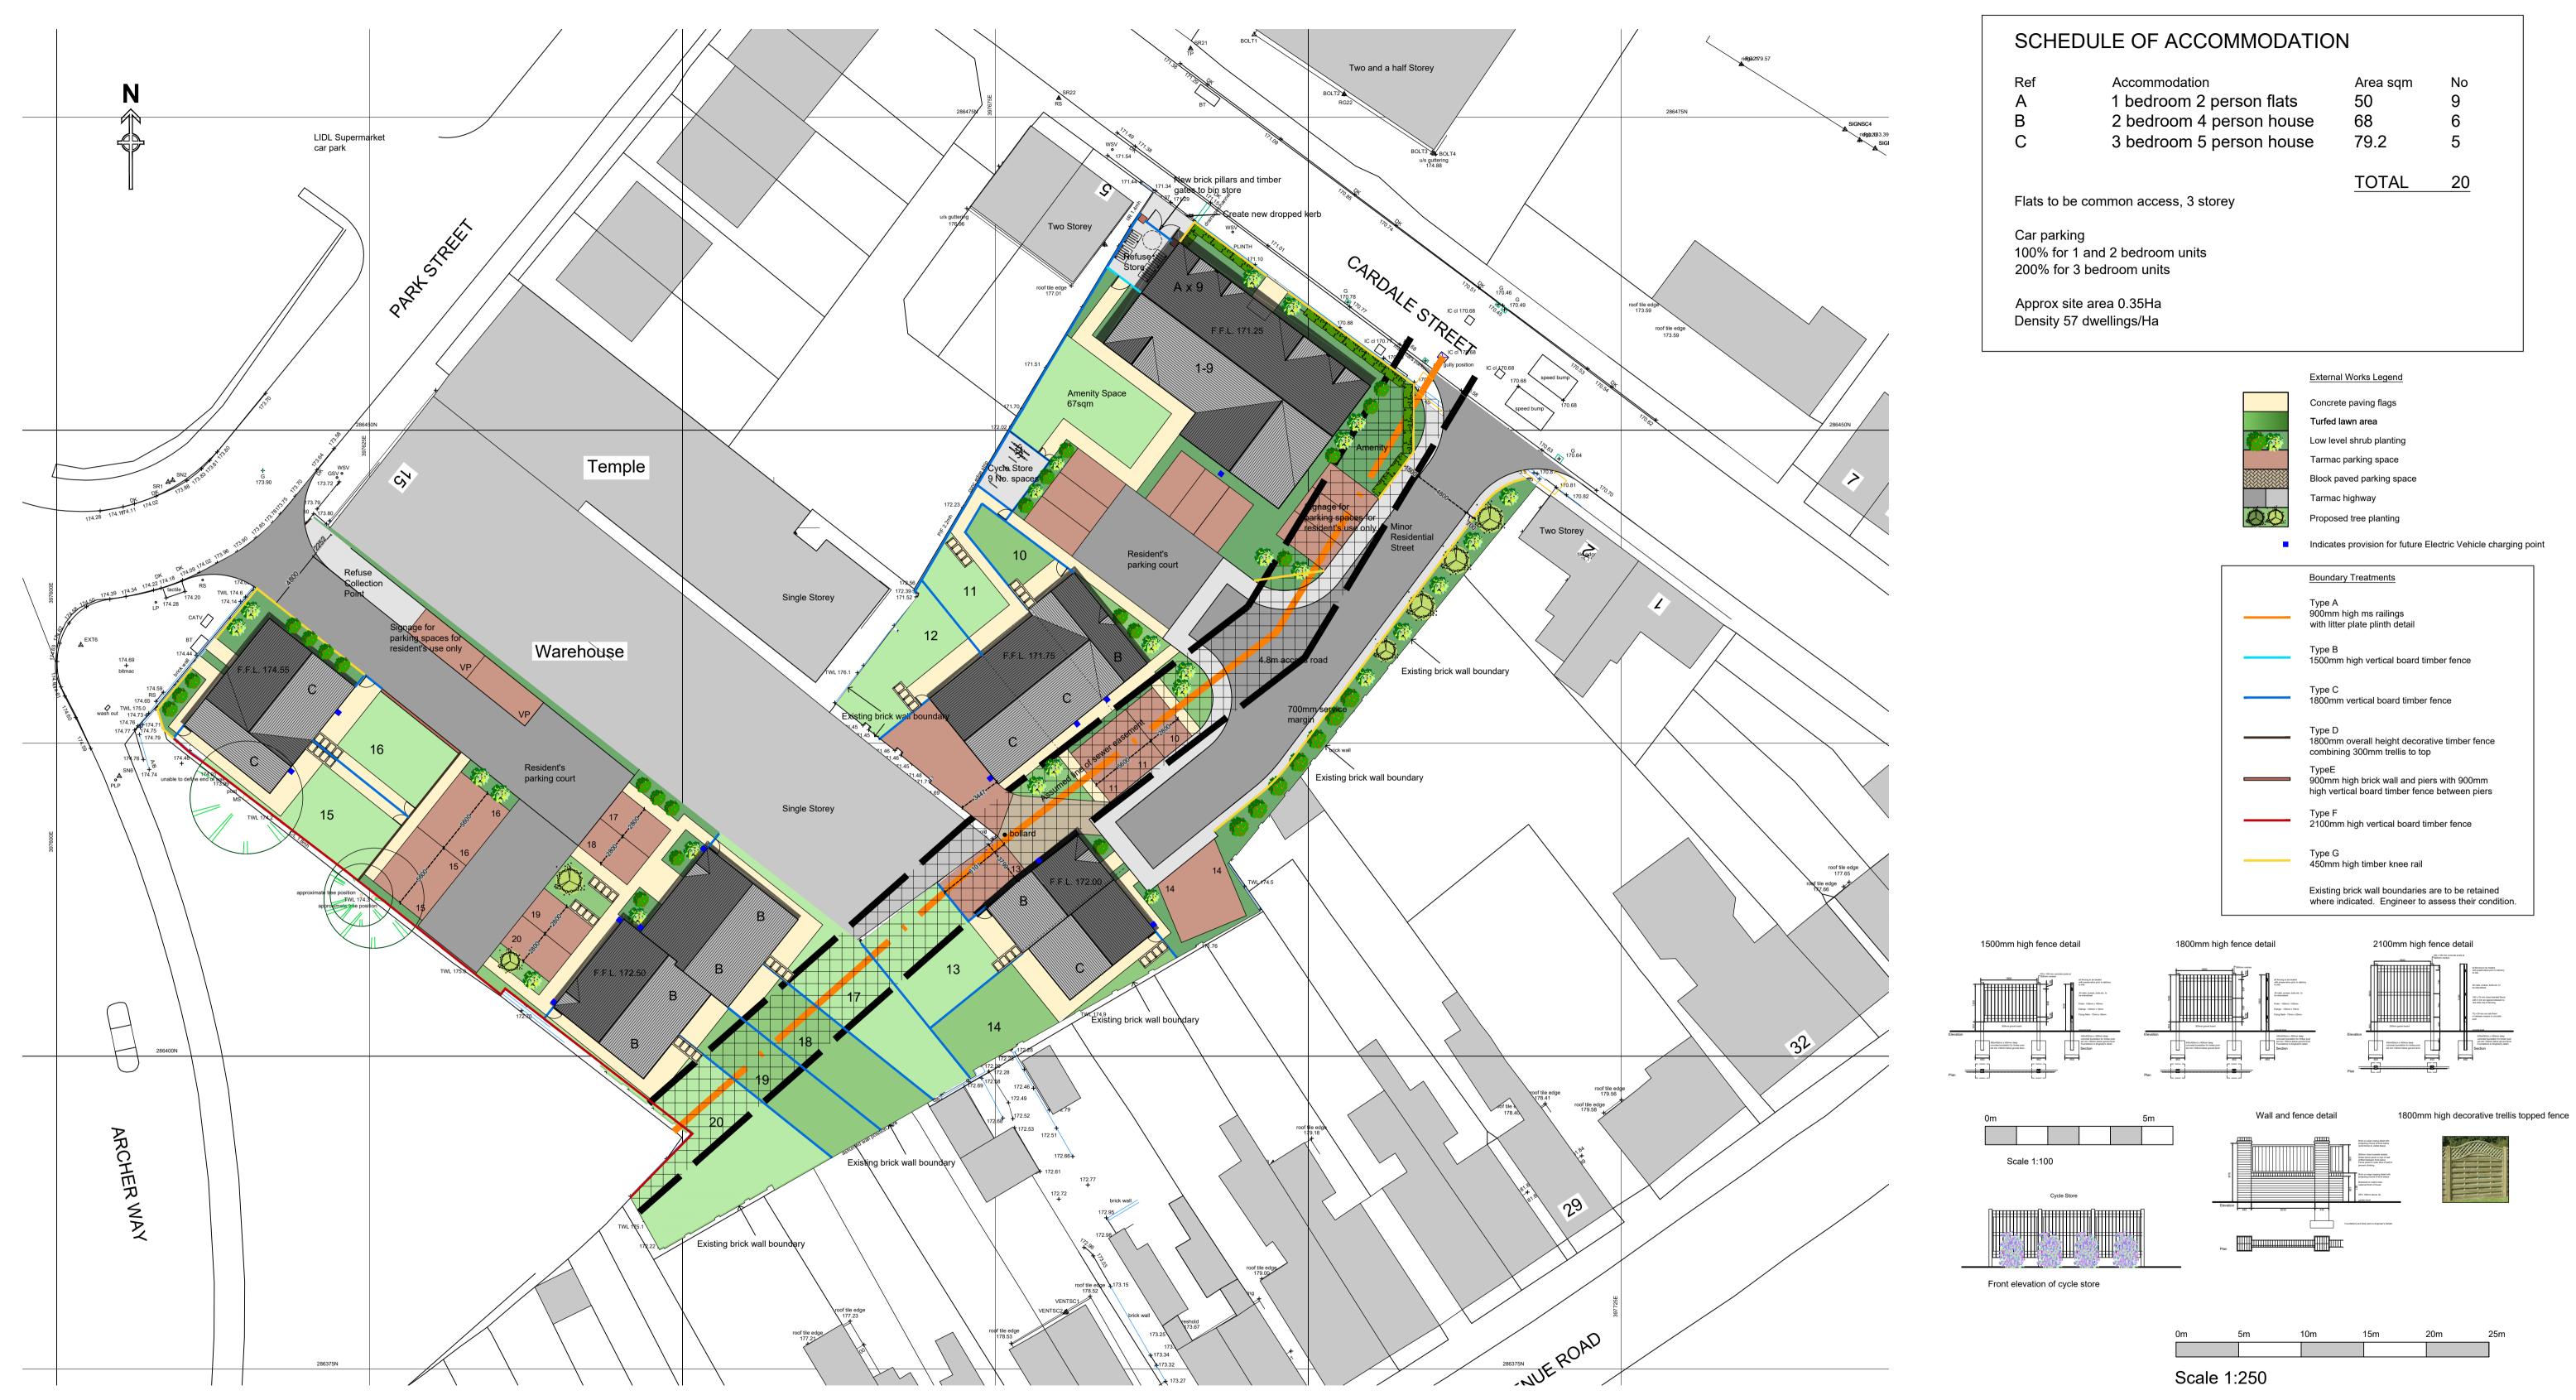Parking spaces to houses dimensioned up.

Minor amendments to suit Highways comments.

Sept 23

Sept 23

Oct 23

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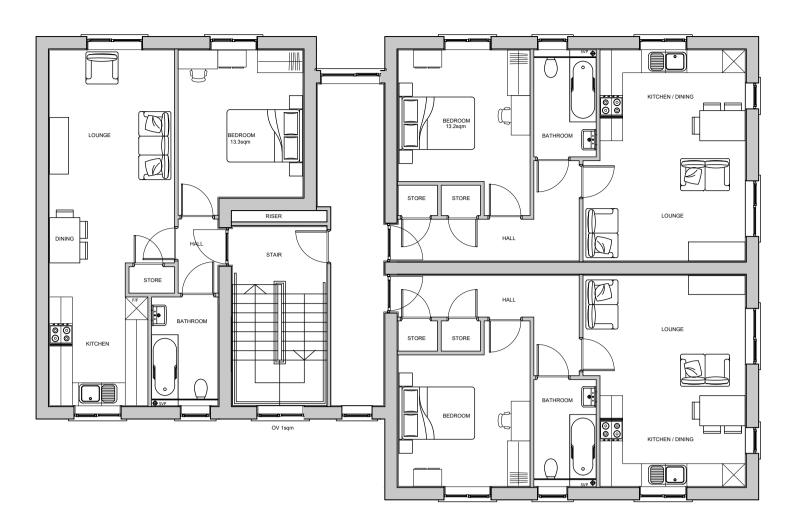
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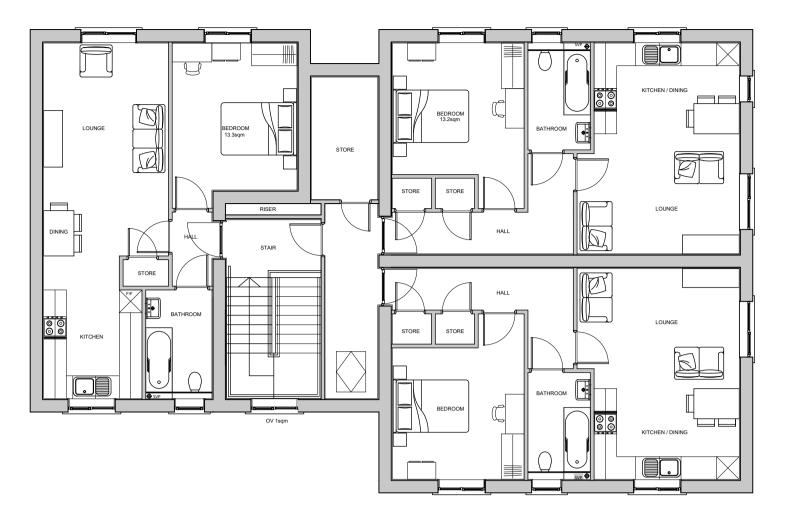
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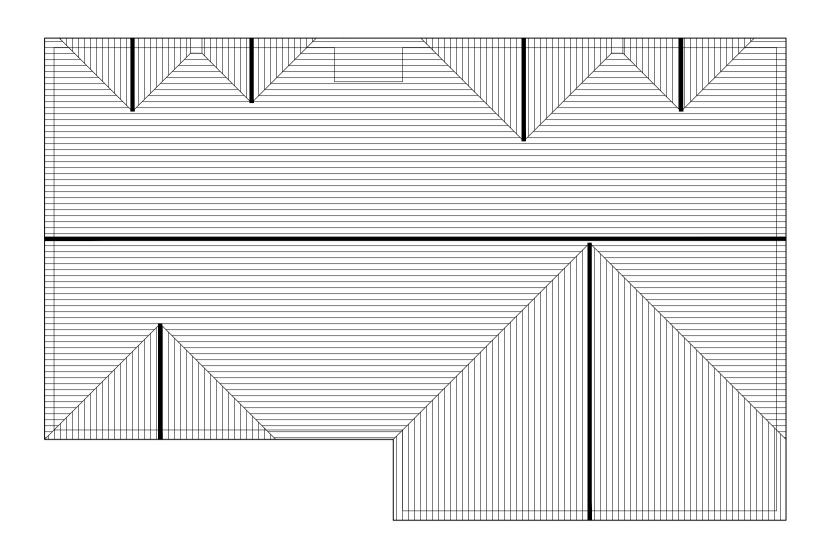
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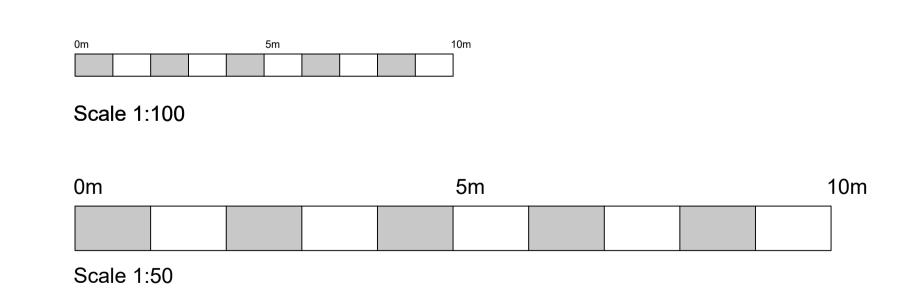


Roof Plan

First Floor Plan

Second Floor Plan





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Revision	Date	Details
Α	Jan 23	Communal corridor reduced at upper levels at TLA request.
В	Feb 23	Communal corridor reverted back to previous design at TLA request.
С	June 23	Apartment sizes amended at TLA request.
D	June 23	Minor window position changes to suit updated elevations.
E	June 23	Second scale bar added at request of Planning.
F	Sept 23	Apartments increased to 50sqm at request of Planning.

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Date:	Jan 2023				
Drawn by/ checked b	D\A/				



Elevation to Cardale Street
Scale 1:50




Elevation to car parking Scale 1:100



Gable Elevation
Scale 1:100



Elevation to new access road

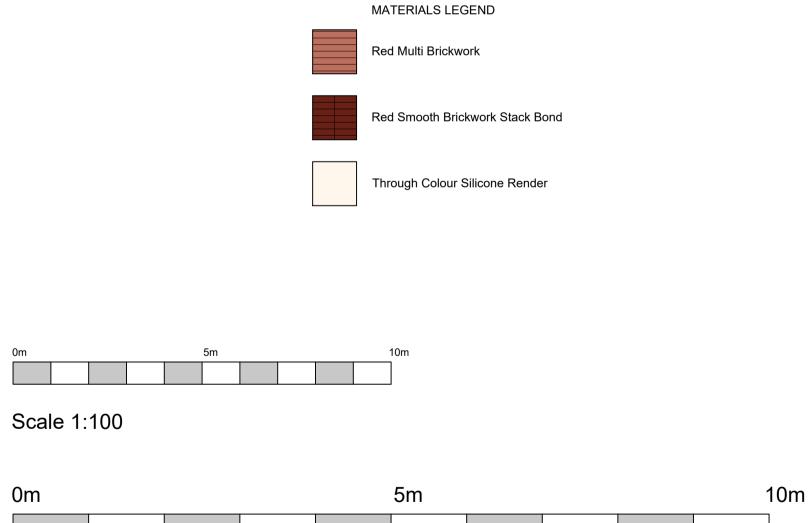

0m 5m 10
Scale 1:50

Revision	Date	Details
Α	Jan 23	Communal corridor reduced at upper levels at TLA request.
В	Jun 23	Changes to elevations to suit reduced floor areas.
С	June 23	Second scale bar added at request of Planning.
D	Sept 23	Elevations amended to suit increase to 50sqm.

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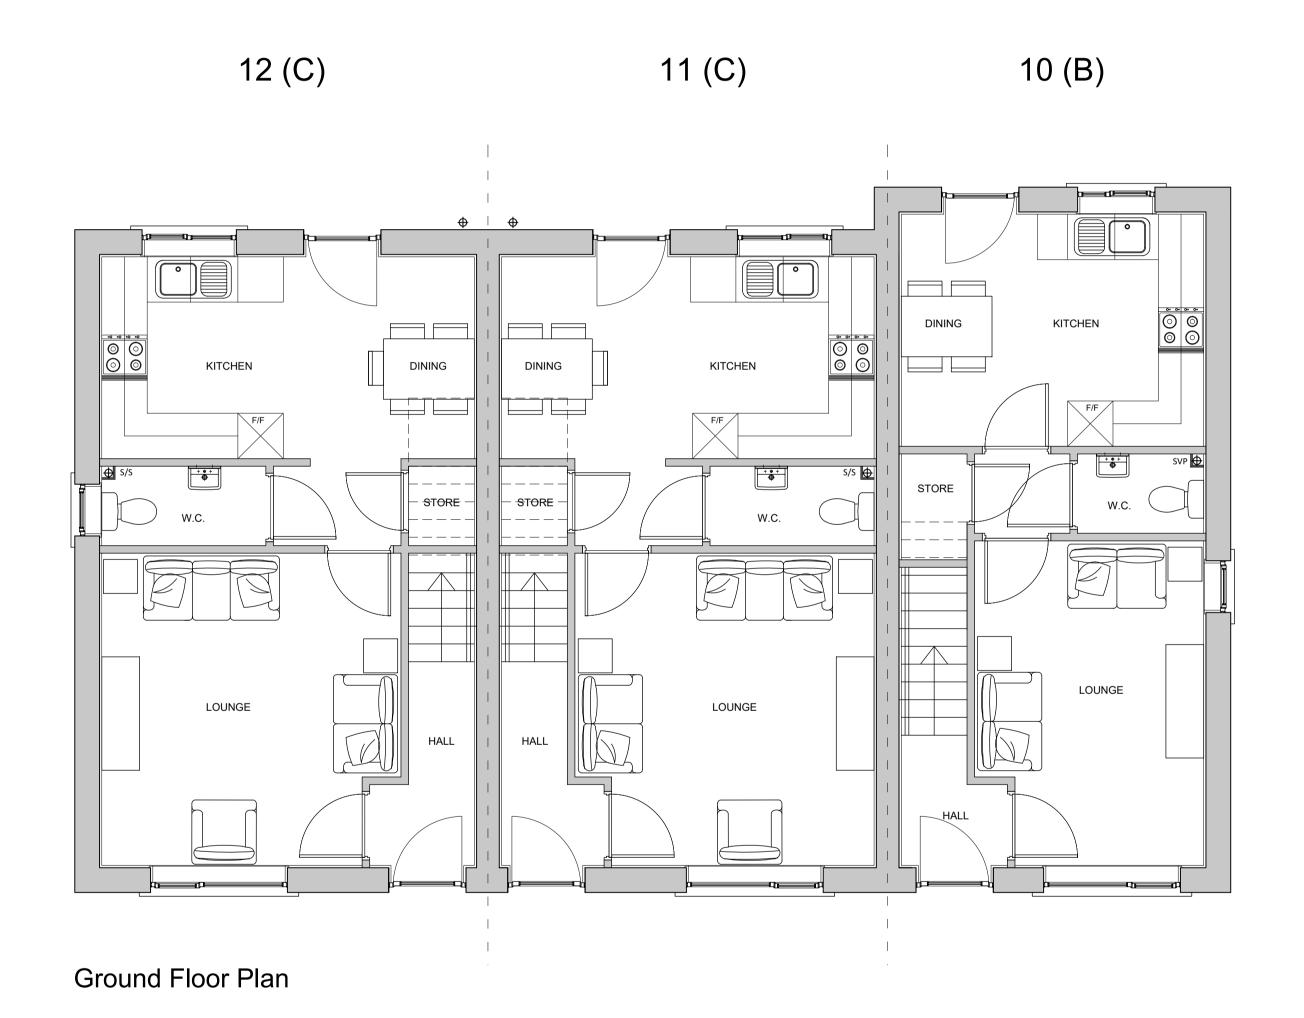
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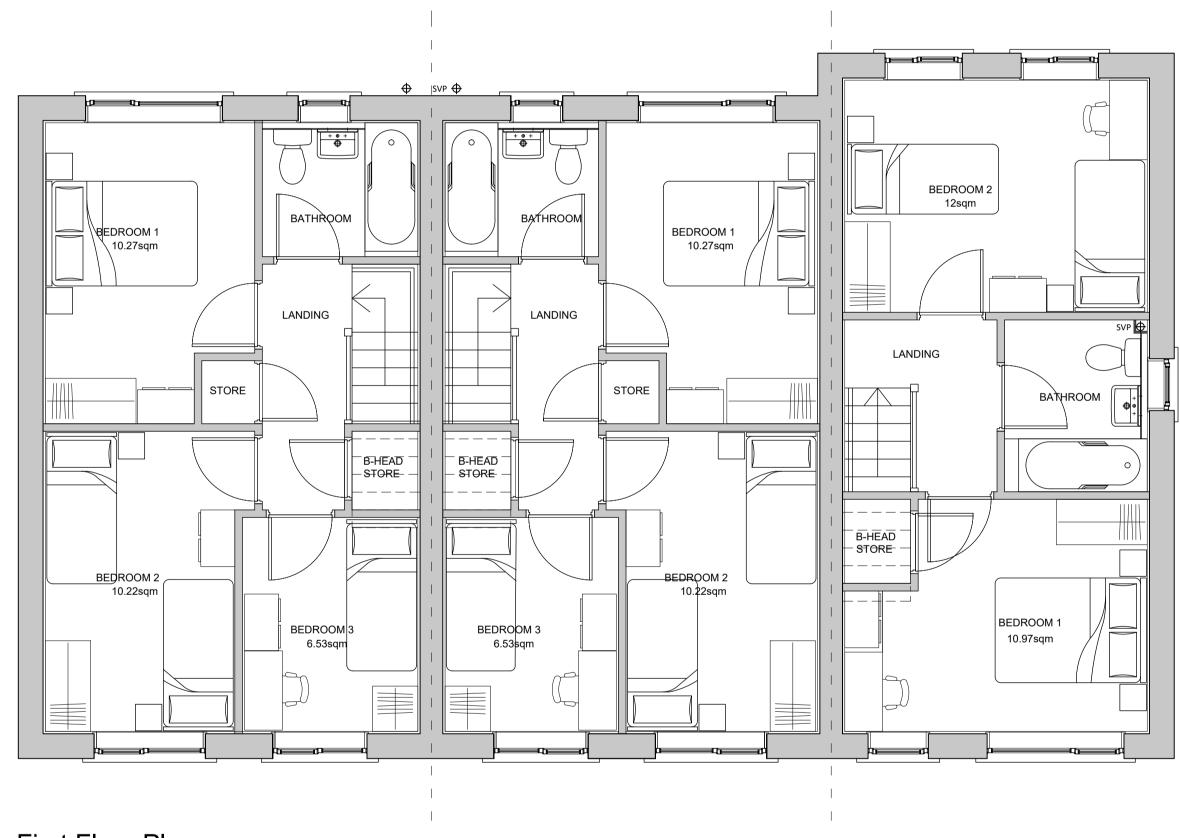
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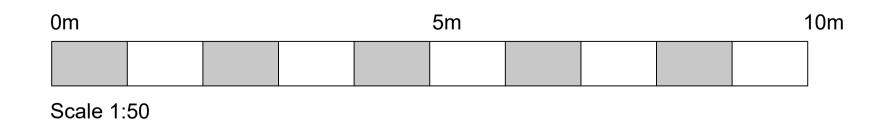
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Date:	Jan 2023	Jan 2023			
Drawn by/ checked b	v: RW				





First Floor Plan



Revision	Date	Details
Α	June 23	Drawing issued for Planning.

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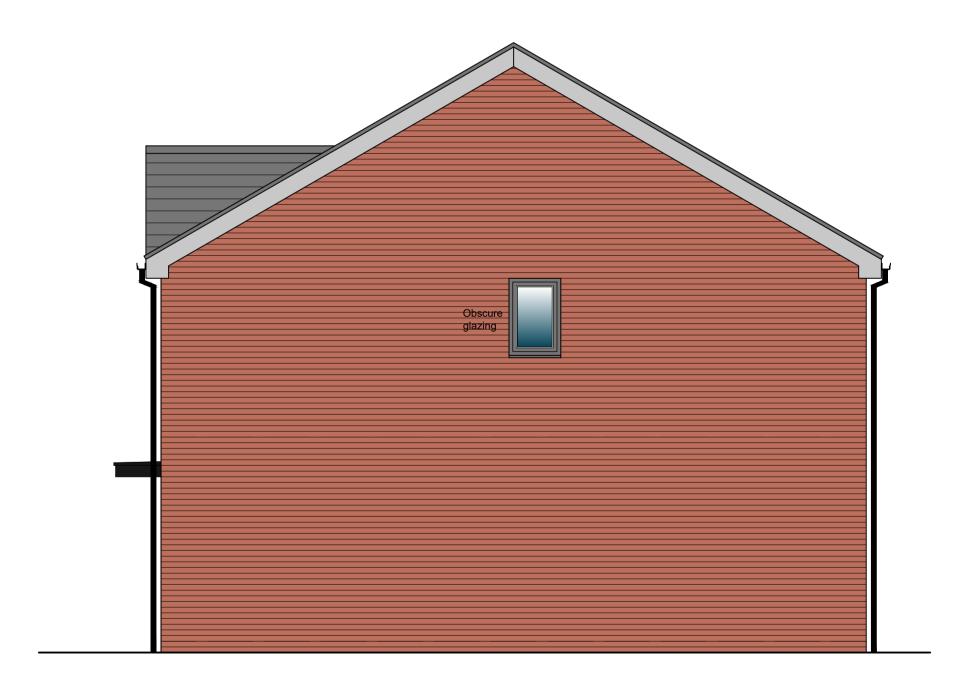
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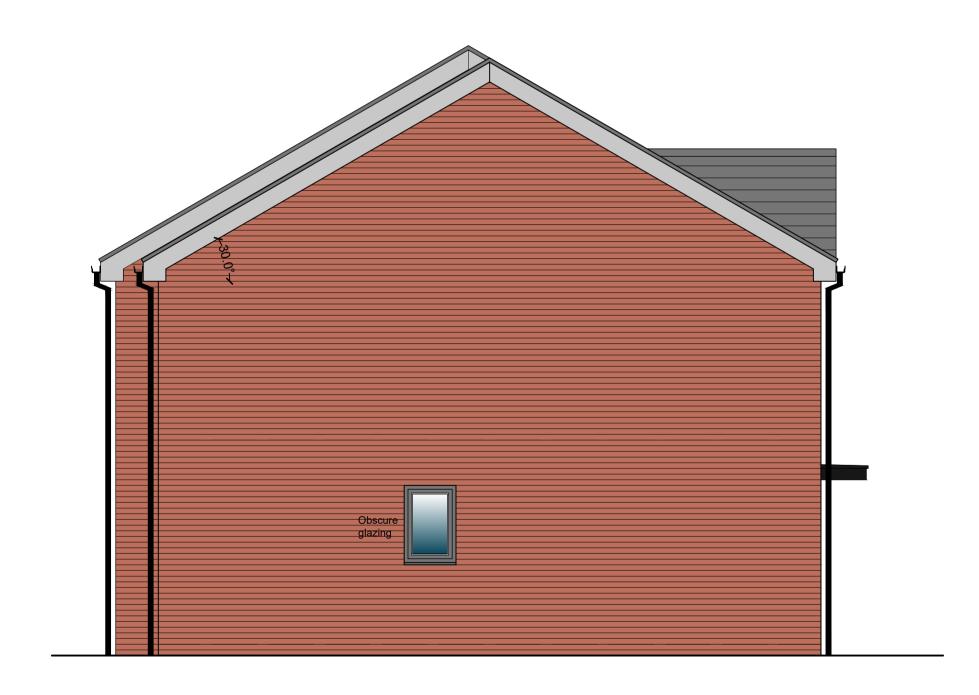
Front Elevation



Rear Elevation




Gable Elevation to Plot 13



Scale 1:50

Gable Elevation to Plot 14

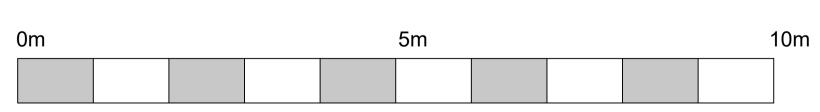

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MATERIALS LEGEND

Red Multi Brickwork

Red Smooth Brickwork Stack Bond

Through Colour Silicone Render

evision	Date	Details
A	June 23	Drawing issued for Planning.

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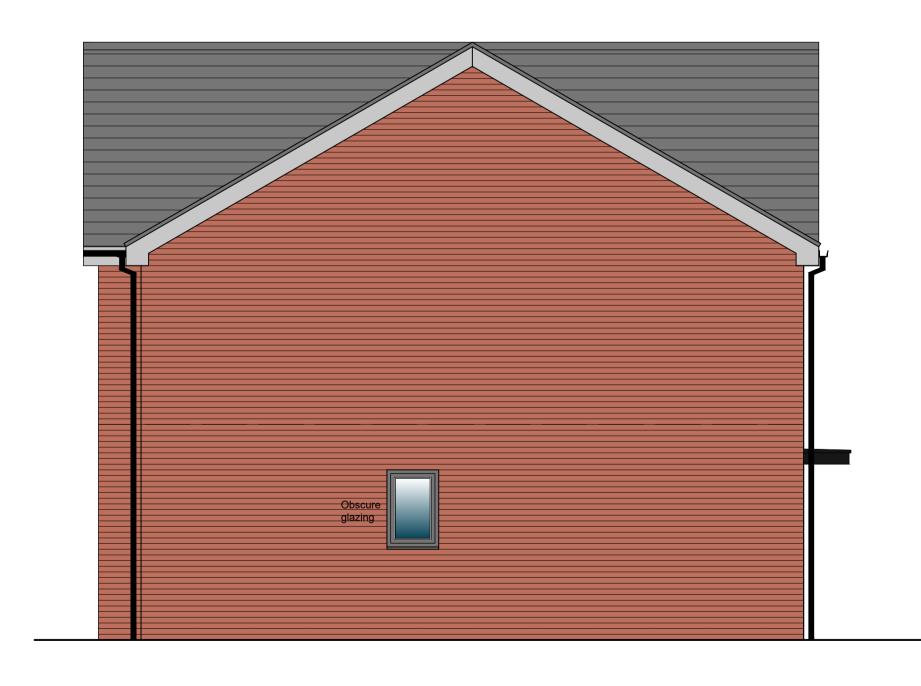
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Gable Elevation to Plot 12

	Red Multi Brickwo	ork			
	Red Smooth Brick	work Stack B	ond		
	Through Colour S	ilicone Rende	r		
0m	5m				10m
Scale 1:50					

MATERIALS LEGEND

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Revision	Date	Details
Α	June 23	Drawing issued for Planning.
В	June 23	Scale bar added at request of Planning.

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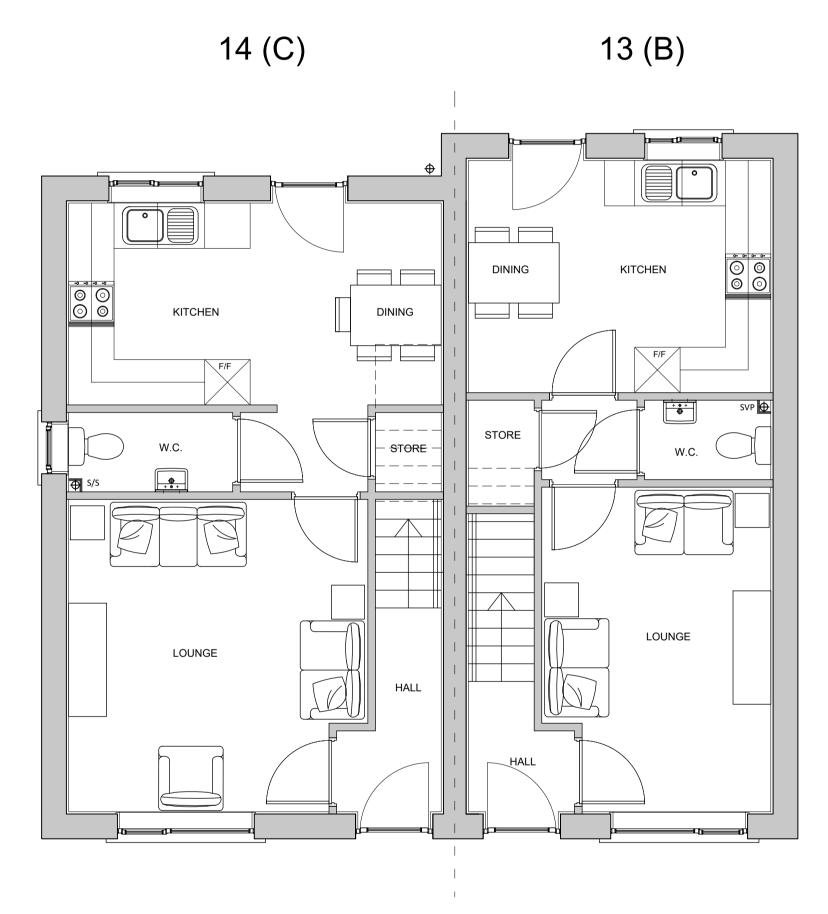
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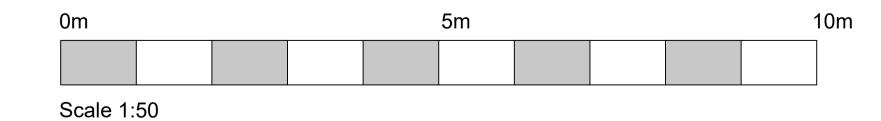
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Ground Floor Plan



First Floor Plan



Revision	Date	Details
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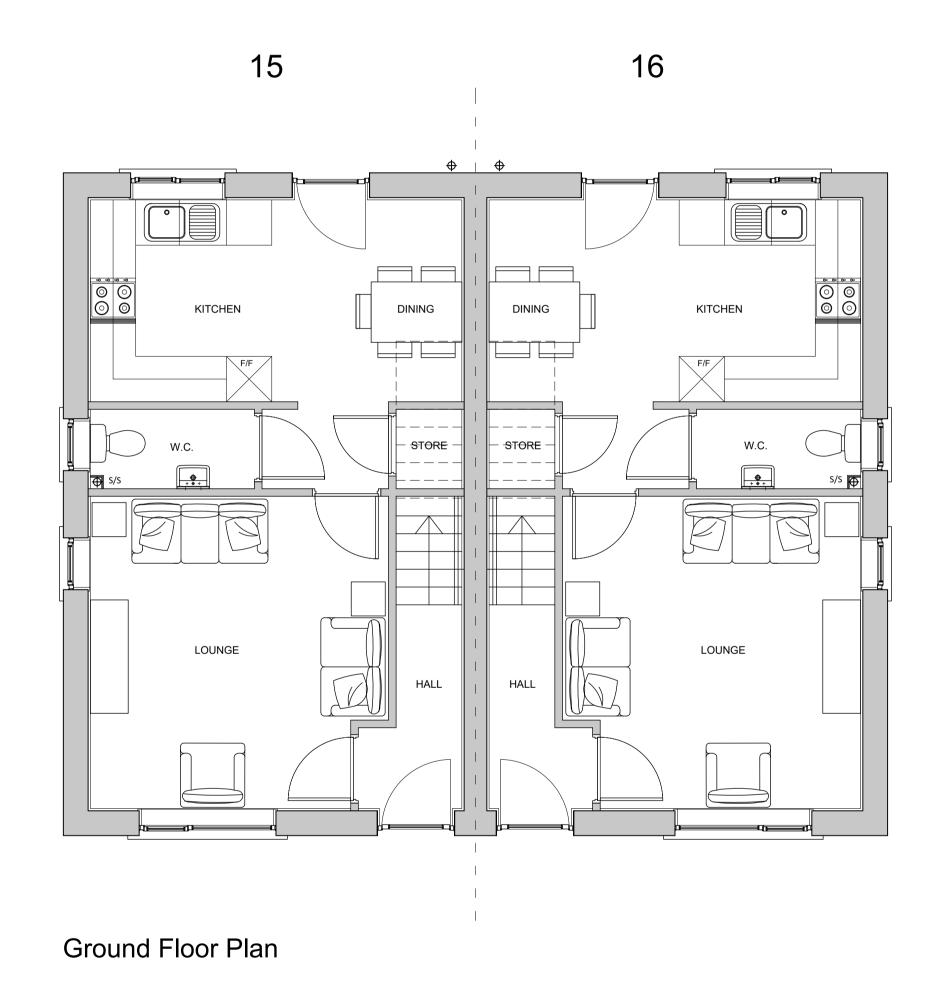
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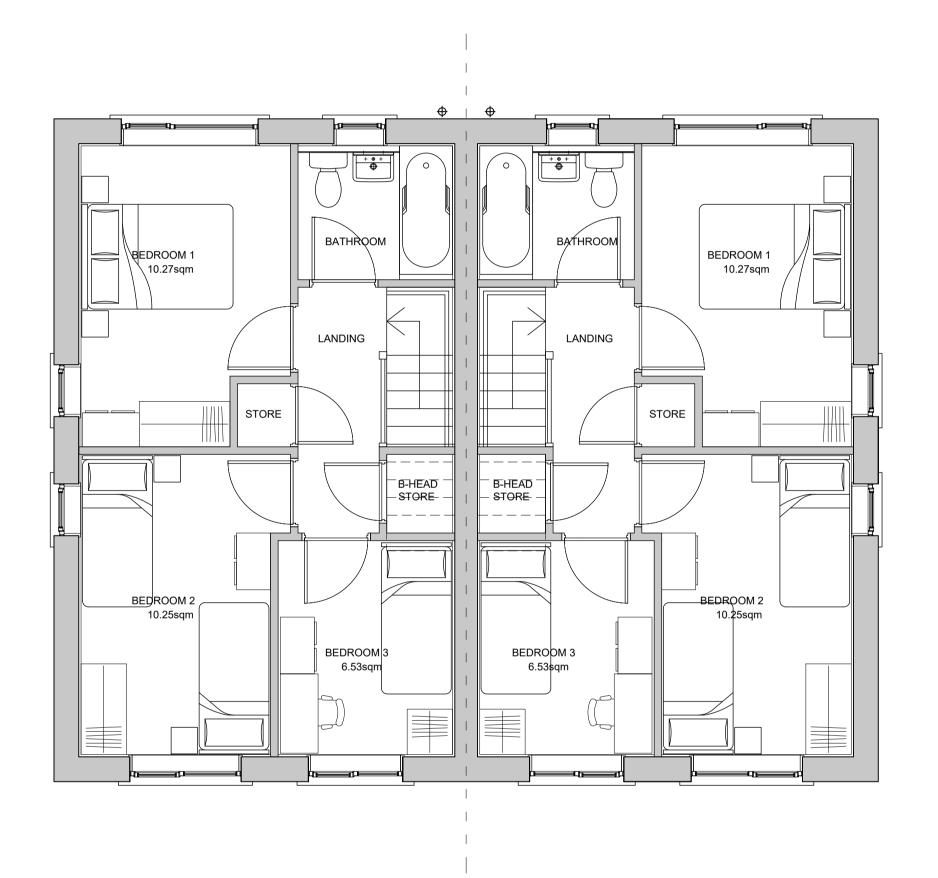
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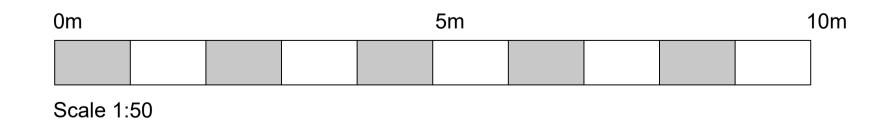
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First Floor Plan



Revision	Date	Details
Α	June 23	Drawing issued for Planning.

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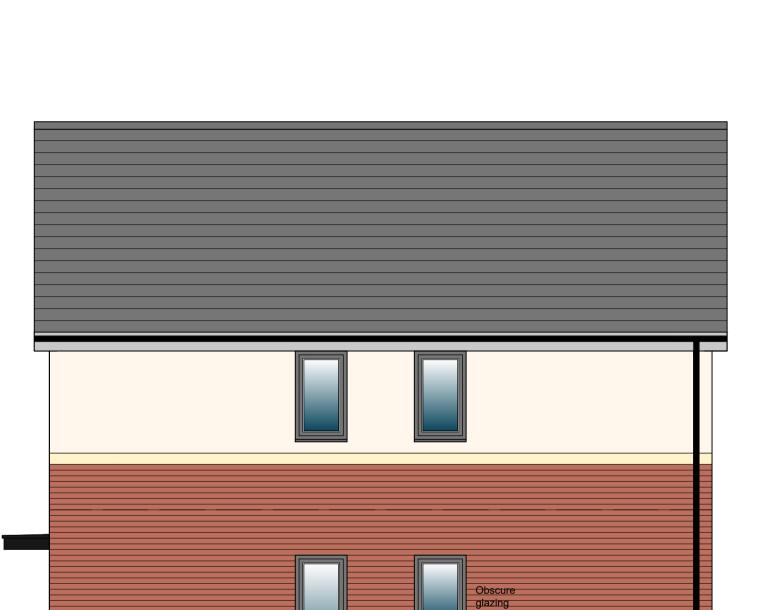
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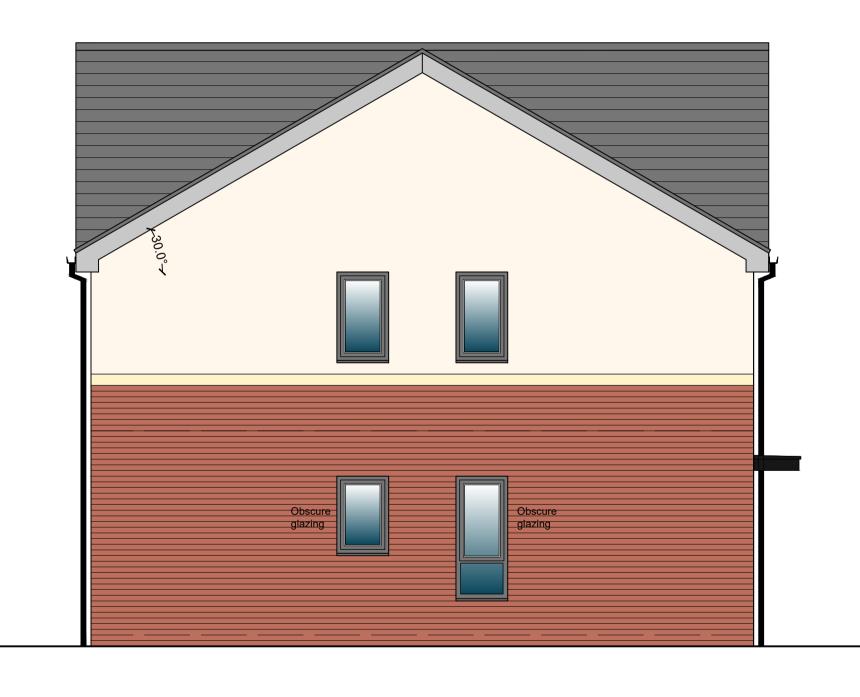
Front Elevation




Gable Elevation to Plot 15



Rear Elevation



Gable Elevation to Plot 16

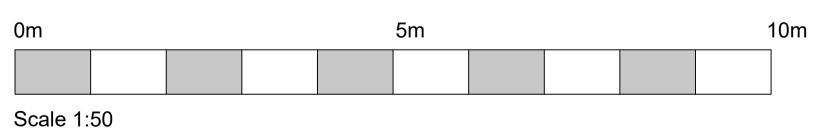

MATERIALS LEGEND

Red Multi Brickwork

Red Smooth Brickwork Stack Bond

Through Colour Silicone Render

Revision	Date	Details
Α	June 23	Drawing issued for Planning.
В	Sept 23	Render continued round gable at request of Planners.

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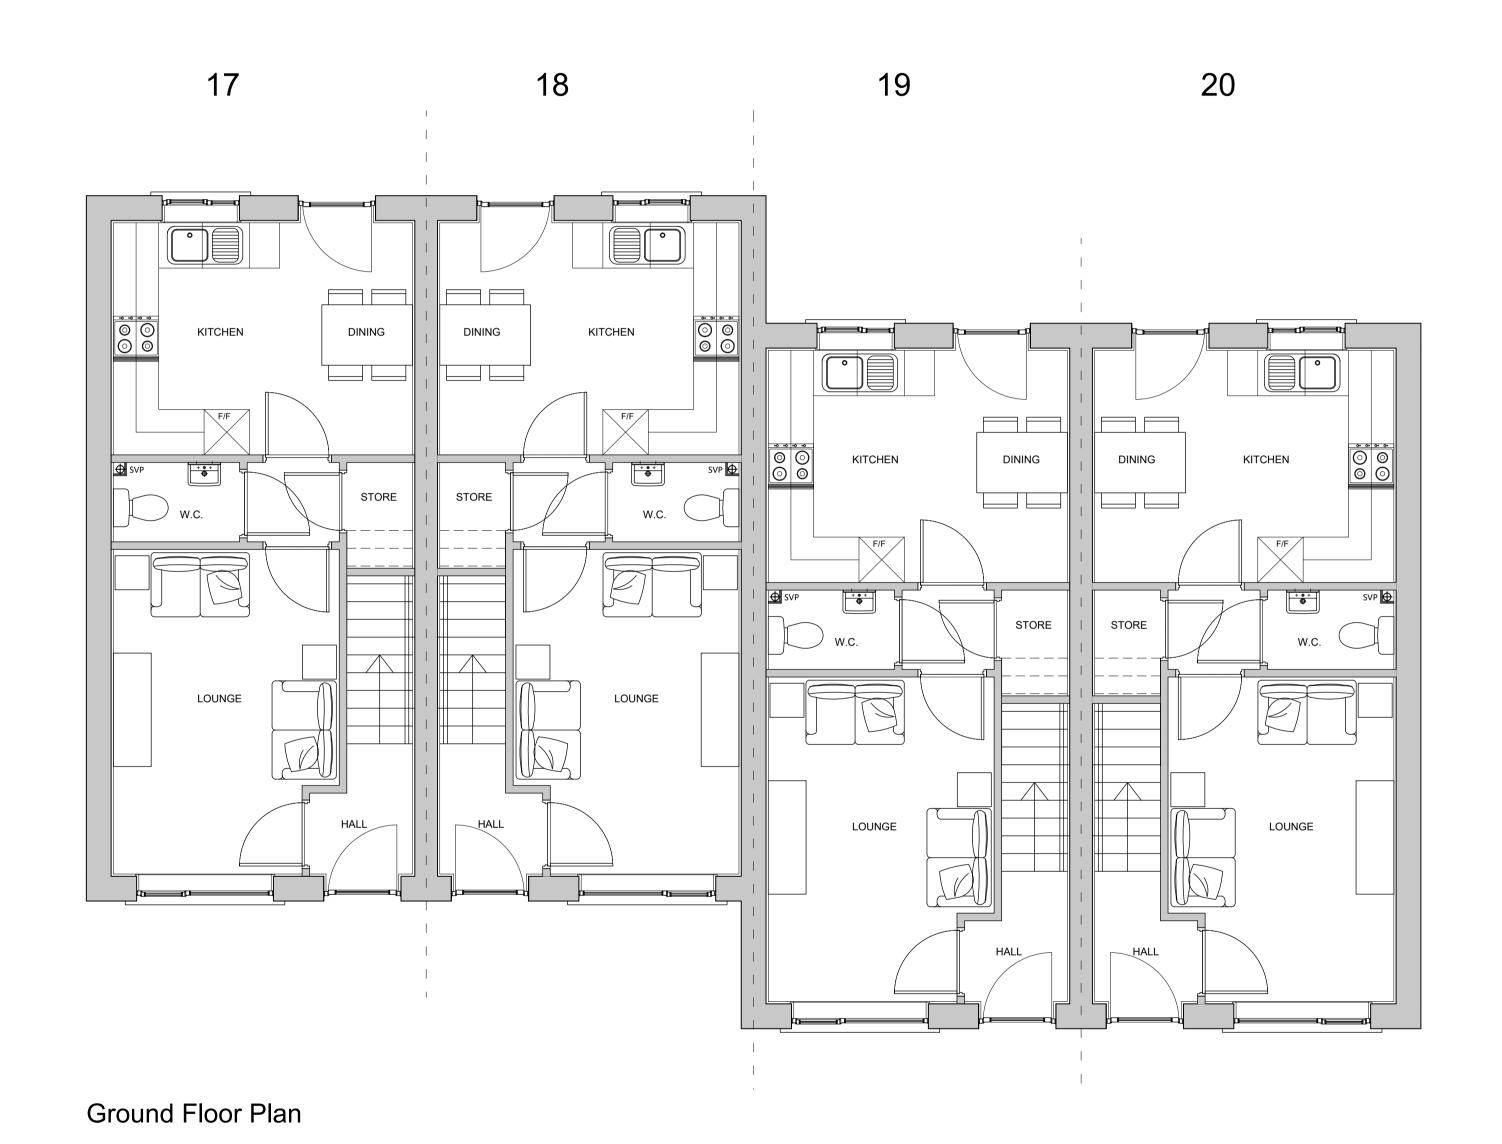
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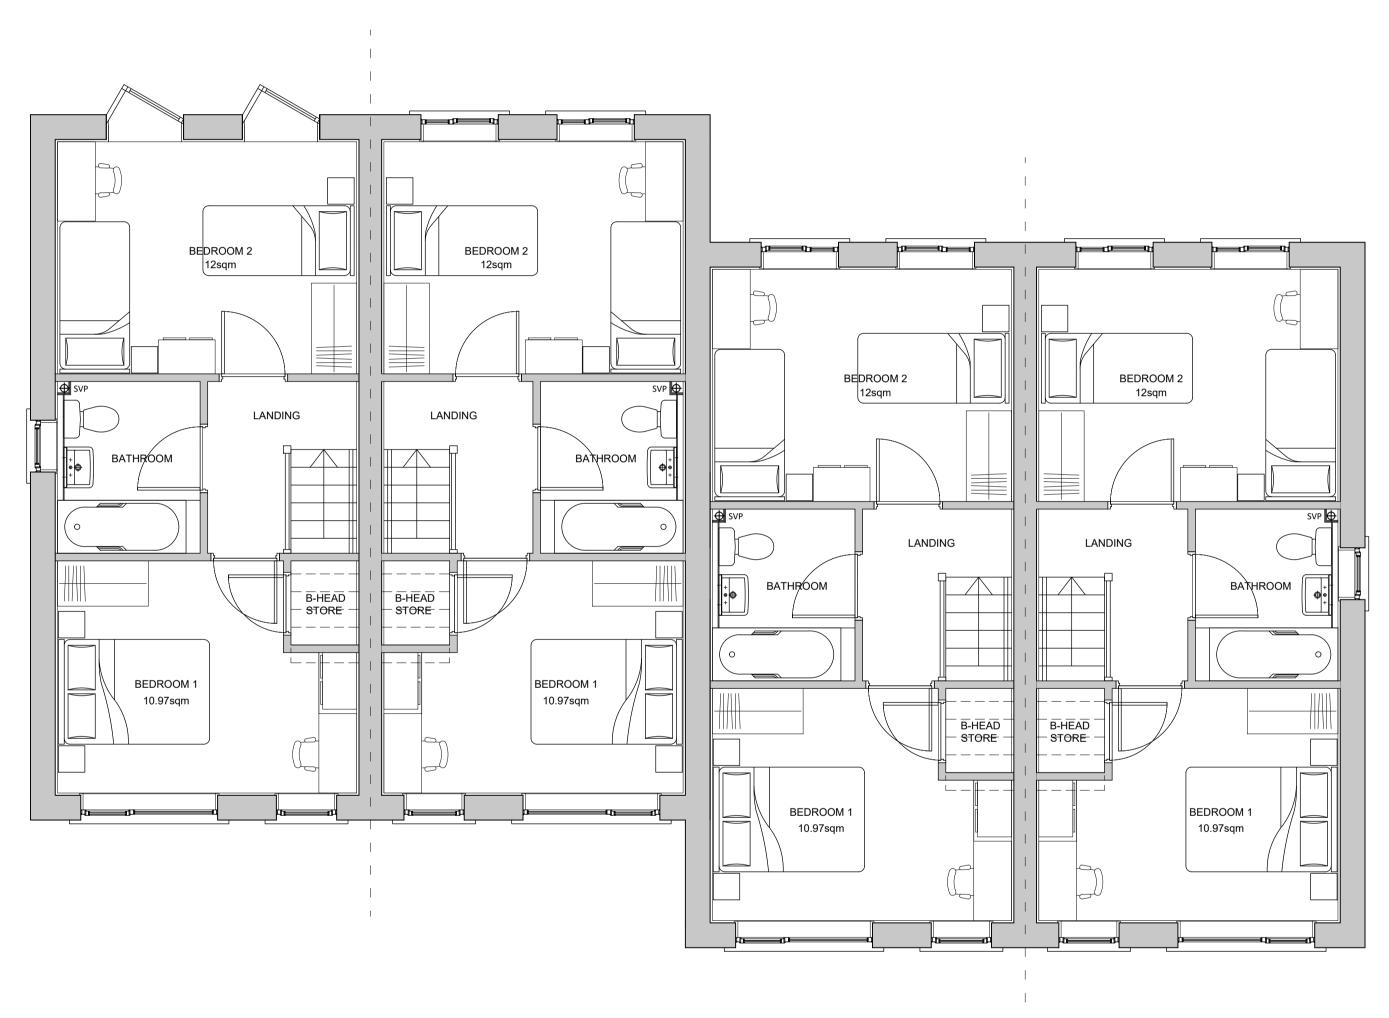
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Job:	Cardale Stre	Cardale Street, Rowley Regis				
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Drawing Number: (Job number)	M4961	(PL)	12	Revision B		
Scale:	1:50 @ A1	_		 		
Date:	Jan 2023					
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First Floor Plan



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Revision	Date	Details
Α	June 23	Drawing issued for Planning.

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Client:	Taylor Land Associates				
Job:	Cardale Street, Rowley Regis				
Drawing title:	Floor Plans Plots 17-20				
Drawing Number: (Job number)	M4961	(PL)	13	Revision	
Scale:	1:50 @ A1		1		
Date:	Jan 2023				
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Revision	Date	Details
Α	June 23	Drawing issued for Planning.

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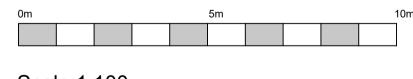
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Client:	Taylor Land Associates				
Job:	Cardale Street, Rowley Regis				
Drawing title:	Elevations Plots 17-20				
Drawing Number: (Job number)	M4961	(PL)	14	Revision:	
Scale:	1:50 @ A1				
Date:	Jan 2023				
Drawn by/ checked by:	RW				



Street Scene along Cardale Street Scale 1:100



Scale 1:100

Revision	Date	Details	

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Client:	Taylor Land A	Taylor Land Associates				
Job:	Cardale Stree	Cardale Street, Rowley Regis				
Drawing title:	Cardale Street Elevation					
Drawing Number: (Job number)	M4961	(PL)	15	Revision		
Scale:	1:100 @ A1		I			
Date:	Jun 2023					
Drawn by/ checked b	v. BM					

Cardale Street Rowley Regis



HEDGES Abbreviations Species Double staggered row 60-80cm

Hakonechloa macra 'Aureola'

Lavandula angustifolia 'Vera'

Prunus laurocerasus 'Otto Lukyen'

Pulsatilla vulgaris

Stipa barbata

Specification

Preparing for topsoiling
Grading and cultivation shall be in accordance with BS 4428:1989 section 4. Subsoil that is to receive topsoil shall, whether obviously overcompacted or not, be thoroughly broken up by hand, by heavy rotovator, by subsoiler or tined equipment with adequate passes made to thoroughly break up the surface to a depth of 150mm, cleared of all large stones, bricks, perennial weeds, tree roots (excluding living tree roots), coarse vegetation and other extraneous matter.

Subsoil shall only be graded after loosening as above, and this shall be undertaken by the use of a tractor and blade grader on large areas and by a small mechanical grader or by hand on small areas. Ground shall at no time be traversed by heavy machinery, for grading or any other purpose after subsoiling and/or topsoiling has taken place.

Making up levels

When subsoil is deposited in low lying areas to raise formation levels, it shall be lightly consolidated and left broken up ready to receive topsoil. Imported fill material shall be natural subsoil free from metal, concrete or organic material with any one dimension greater than 100mm. All imported fill material shall be approved by the Landscape Architect prior to spreading on site.

Supply of topsoil

Topsoil to be supplied shall be approved by the Landscape Architect and details of the source of supply shall be provided in order that inspection may be made before delivery commences. Topsoil shall conform to BS 3882: 2015, Recommendations and classification for topsoil, clause 4.1a. The soil shall be free of weeds, roots or perennial weeds, pests, diseases, debris, tree roots, sticks, subsoil and foreign matter and shall be capable of being broken down to a fine

The depositing of temporary heaps of topsoil shall be so arranged that possible damage to existing grass, plants, tarmacadam, paving etc, is avoided. Unless otherwise agreed by the Landscape Architect, temporary spoil heaps shall be on protected ground. Such protection shall take the form of tarpaulins, plastic sheets, boards or similar covering. If damage does occur, it shall be made good at the contractor's own expense. Areas excavated to receive topsoil but have not had the base loosened shall not be used as temporary off loading areas. If the bottom of the excavation has been loosened off, loading on these areas is permissible.

Prior to topsoil replacement the formation level shall be cleared of all stones, rubbish, debris with any one dimension greater than 75mm. Areas to be seeded or turfed shall be covered by topsoil 100mm thick and areas to be planted shall be covered by topsoil 400mm thick. Topsoil shall be spread in an evenly consolidated layer and shall be left cleared of all roots, stones and debris with any one dimension greater than 50mm throughout its depth. Unless otherwise stated the finished level shall be 25mm above adjacent hard areas. No topsoil shall be spread until the subsoil grade has been inspected by a Landscape Architect.

Planting areas shall be rotovated to a depth of 225mm in the original ground, or

where the ground is compacted, ripped and rotovated. Pick off stones, bricks, timber and all other debris arising which have any dimensions greater than 50mm and remove off site to tip. Do not cultivate across any drain where the stone is flush with the ground surface.

Where directed composts, fertilisers or other additives shall be incorporated into the soil. Spent mushroom compost or similar shall be spread to the specified thickness and incorporated, by rotovating, into the top 150mm. Fertilisers, organic or inorganic, shall be raked into the top 25mm.

All plant material should comply with the minimum requirements in BS 3936-1: 1992 Specification for trees and shrubs and BS 3936-4: 2007 Specification for forest trees. Any plant material, which in the opinion of the Landscape Architect, does not meet the requirements of the Specification, or is unsuitable, or defective in any other way, will be rejected. The minimum specified sizes in the plant schedule will be strictly enforced. The contractor shall replace all plants rejected

All plant material shall generally be planted between November and March in open cool weather. Planting shall not take place in frosty, snowy or waterlogged conditions. Where approved, pot or container grown plants may be planted outside the described season, but adequate watering shall be supplied. Torn or damaged roots and branches shall be cleanly pruned prior to planting.

Planting of whips, transplants and shrubs

The nature of the material to be planted is variable and the contractor shall allow for planting to be properly carried out in all cases as described in BS 4428: 1989 section 7 Amenity tree planting, section 8 Woodland planting and section 9 Planting of shrubs, herbaceous and bulbs. All plants shall be planted at same depth, or very slightly deeper, as they were grown. Roots shall not be bent, broken or forced into inadequate pits or notches. Plants shall be upright, firmed in and wind resistant, with no air pockets around roots. All pots and root wrappings shall be carefully removed prior to planting. All pots and wrappings arising shall immediately be picked up and stored ready for removal to tip. Plants shall be planted at the specified centres. On steep slopes this shall be in the horizontal

Tree planting within soft landscape areas Trees shall conform to BS: 3936-1: 1992 and be planted in tree pits of the

following sizes unless directed otherwise: Feathered trees - 900 x 900 x 450

Selected standards - 1000 x 1000 x 600

Heavy standards/Extra heavy standards - 1200 x 1200 x 600 Excavated subsoil or stone shall be carted off site to tip. The bottom 250mm of the pit shall be dug and broken up. The bottom of the pit shall be backfilled with subsoil (site or imported) to comply with BS 8601: 2013. The top 300mm of the pit shall be backfilled with imported topsoil as specified unless directed otherwise.

Compost for planting pits

Compost shall be a proprietary product, bark based incorporating fertilisers and improving additives. The type of compost shall be approved before its delivery on site, and the details of the product shall be supplied. Cambark planting compost is approved. Where directed compost shall be added to and mixed with topsoil backfill at the following rates: Feathered trees - 40 litres

Selected standards - 60 litres Heavy standards/Extra heavy standards - 80 litres

Stakes for trees

follows unless directed otherwise

Stakes shall be peeled round softwood, pointed, minimum diameter 75mm. The stakes shall be driven into the base of the tree pit prior to placing the tree and Stakes shall in general have a clear height above the finished ground level as

Feathered trees - 750mm (one tie) Selected standards - 900mm (2 stakes, one tie each)

Heavy standards/Extra heavy standards - 1200mm (2 stakes, one tie each) The stake shall be long enough to drive until they hold the tree firmly without

Height Girth Pot Size Density Number

Double staggered row 30-40cm

5L 6/m

Ties for bareroot trees, shall be approved rubber nail-on type with cushioned spacer such as Toms, or other equal and approved. Nails shall be flat headed galvanised and shall hold the ties securely into the stake. Ties shall not be over tight on the tree stems. Ties available from J Toms Limited, Wheeler Street, Headcorn, Ashford, Kent, TN27 9SH. Feathered Type - 04 (one tie)

Select standards - Type L1 (one tie per stake) Heavy standards/Extra heavy standards - Type L3 (one tie per stake

Ties for rootball and container grown trees shall be 50mm rubber tree belts in a figure of eight around the tree. Fixed to the stake with two flat head galvanised

Feathered - one belt Select standards Type - two belts

Heavy standards/Extra heavy standards - two belts

The tree shall be set upright and at the same depth as grown in the nursery, the roots shall be spread out (bareroot) and the suoil followed by compost topsoil mixture, backfilled. Backfilling should be done to ensure close contact between roots and by firming in layers (bareroot). The soil shall be left level and tidy, any subsoil clods, bricks or stones over 50mm arising, collected and carted off site.

A 75mm compacted layer of medium grade pulverised bark, with a particle size of not more than 100mm and containing no more than 10% fines, shall be spread to form a continuous layer covering the whole of the bed, or in the case of standard trees within grass shall be in the form of a circle of 600mm diameter around the base of the tree. Whips and transplants shall be mulched in the form of a 300mm diameter circle around the base of the tree. Where trees are planted within grass a circular hemp mulch mat is required beneath the layer of mulch at the diameters stated above, secured with fixing pegs. The tree pit surface shall be as big as

Soil preparation and cultivation

All areas to be turfed shall be cultivated to a depth of at least 100mm, all weeds, stones and refuse larger than 50mm shall be removed to Contractor's tip, and shall be brought to a fine tilth. Allow for hand cultivation where machine work is

Turf shall be extra-quality meadow turf and shall comply to BS 3969: 1998 +A1: 2013 and shall be laid in accordance with BS 4428: 1998, section 6, Turfing. The Contractor shall supply a sample of the turf he proposed to use for approval of the Landscape Architect and shall ensure that all turves are similar to the approved sample. The Contractor shall inform the Landscape Architect of the location of the supply, so that turf can be inspected prior to lifting.

Turf shall be laid when weather and soil conditions are suitable and, where possible, preference should be given to autumn and early winter operations. No turf shall be laid in exceptionally dry or frosty weather or in other unsuitable

For large areas, turf shall be delivered at appropriate intervals throughout the work so as to avoid stacking for long periods.

No turf shall be laid until the soil preparation has been satisfactorily completed by being brought to an even tilth and firmness. Turves from the stack shall be wheeled to turf layers on planks laid closely side by side. Adequate timber planks shall be used to support operatives and barrows, and provide access. The turves shall be laid in consecutive rows with broken joints (stretcher bond), closely butted and to the correct levels. The turf shall be laid off planks working over turves previously laid. Where necessary, the turves shall be lightly and evenly firmed with wooden beaters, the bottom of the beaters being frequently scraped clean of accumulated soil or mud. A dressing of finely sifted topsoil shall be applied and well brushed into the joints. Any inequalities in finished levels owing to variation in turf thickness or uneven consolidation of soil shall be adjusted by raking and/or packing fine soil under the turf. A roller shall not be used. The finished levels of the turf shall conform to the levels indicated, allowing for final settlement. Turf edges and margins shall be laid with whole turves. Turves adjoining buildings, walls or fences shall be taken to the face of the structure, giving complete soil cover.

Turf shall not be laid to within 300mm of any tree trunk.

The Contractor shall be responsible for the replacement of any scorched turf. All necessary watering shall be carried out with sprinklers or oscillating sprays so as not to wash soil out of joints. If shrinkage occurs and the joints open, fine topsoil shall be brushed in and well watered.

PROTECTION TO EXISTING TREES

The recommendations in BS 5837: 2012, Trees in Relation to Design, Demolition & Construction must be complied with at all times. No pruning, lopping, felling or severance of roots is to take place without prior consent of the local authority.

Any work to the existing trees is to be carried out by a qualified tree surgeon.

The position and construction of protective fencing shall be agreed with the local authority prior to any site works commencing. Under no circumstances must any materials be stored under the canopy of existing trees, and no cement, diesel or oil stored near them. No vehicles should pass under the canopy of existing trees. No fires should be lit in close proximity to existing trees.

No ropes, cables, services or notice boards shall be fixed to existing trees. Under no circumstances should the levels around existing trees be either raised or reduced Scaffolding may only be erected within protected areas if it is done so in

accordance with BS 5837. Any excavations under existing tree canopy spreads shall be done by hand.

MAINTENANCE

All maintenance to be carried out up to handover to the adopting authority/ householder from the date of planting and turfing to ensure successful establishment. All dead, diseased, damaged plants must be replaced during this time unless the local Planning Authority states, in writing, any variation to

All beds to be kept weed free by hand weeding. Beds to be forked over as necessary to keep soil loose to approved cambers with no hollows.

At appropriate time, prune plants to remove dead, dying or diseased wood and suckers to promote healthy growth and natural shape.

The Contractor shall ensure that sufficient water is applied to maintain healthy

Site to be kept free of litter.

Grass cutting

The initial cut shall be carried out when first growth is apparent, blades set 20mm above ground. The Contractor shall continue cutting at appropriate intervals during the growing season and maintain 40mm high sward until grass areas are handed over. Watering, weeding, cutting, repair of all erosion and settlement and re-seeding as necessary to establish a uniform and healthy

stand of grass shall continue until handover to the householder.

nicol thomas

Client:	Taylor Land Associates				
Job:	Cardale Street, Rowley Regis				
Drawing title:	Landscaping Proposals				
Drawing Number: (Job number)	M4961	(PL)	02	Revision:	
Scale:	1:250 @ A1				
Date:	February 2023				
Drawn by/ checked b	y:				

Amendements to match revised Site Layout plan

Indicative finished floor levels added for drainage work to commence.

Date

Oct 2023

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